CITY OF MERCER ISLAND

COMMUNITY PLANNING & DEVELOPMENT

9611 SE 36TH STREET | MERCER ISLAND, WA 98040 PHONE: 206.275.7605 | www.mercerisland.gov



March 17, 2022

Mark Wischman P.O. Box 500 Mercer Island, WA 98040

Sent via email: mark@wischmanmgt.com

RE: Request for Information #2 for File No. SUB21-002 – Angiuli Pacific Res Trust Short Subdivision 4001 West Mercer Way, Mercer Island, WA 98040; King County Tax Parcel # 362350-0365

Dear Mr. Wischman:

The City of Mercer Island received the submittal for the above referenced application for a two (2) lot short subdivision for the property located at 4001 West Mercer Way (King County parcel # 362350-0365). Following review of the application, City staff has determined that additional information is necessary to ensure compliance with the Mercer Island City Code (MICC). Please note that further review of this application is on hold until the following information is provided by the applicant (application status is "WCI" Waiting Customer Information). Please provide the following items:


General:

1. When resubmitting, please submit a response letter to address each review comment. Please also state where the proposed changes can be found (i.e. sheet number, document name, etc.).

Fire comment:

Contact: Jeromy Hicks, Fire Marshal, at <u>Jeromy.hicks@mercerisland.gov</u> or 206-275-7979.

2. Extend the 20' access easement to the edge of the shared property line between Lot A and Lot B, as illustrated in the image to the right:

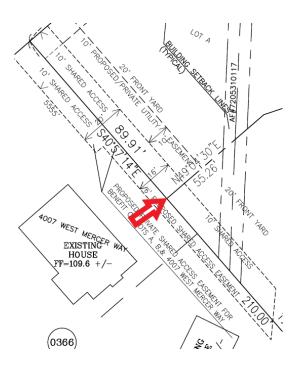

Land Use Planning:

Contact: Lauren Anderson, Planner, at lauren.anderson@mercerisland.gov or 206-275-7704.

- 3. General:
 - a. As requested in the first review letter, please include a signature line for the owner of 4007 West Mercer Way, Judie Wischman. Currently, there are 4 name lines that are blank. Please note the property owners' names and address below the blank signature line as shown below:

Signature line:
Judie Wischman, owner of 4007 West Mercer Way
Signature line:
ANGIULI CARMEN L-TTEE+ET AL, owners of 4001 West Mercer Way

4. Parking:

a. Please note the proposed carport on Lot B to provide 1 covered parking stall will be required to be constructed (with a permit) prior to final short plat application and will be a condition of preliminary short plat approval.

5. Building Pad:

a. In the applicant response letter, it was noted that the building pads were shown on sheet 6 of 9. Sheet 6 of 9, site plan, does not illustrate and label the two (2) building pad areas. Building pad area is different from proposed building footprint. Please refer to Attachment A Building Pad Examples.

6. General:

- a. As requested by Fire, a portion of the proposed 20' access easement on 4007 West Mercer Way will be expanded which will impact net lot area. On sheet 6 of 9 please revise the net lot area for the "new 4007 West Mercer Way."
- b. Due to Lot A net lot area being close to the minimum 15,000sf at 15,002sf, a condition of preliminary plat approval will be that a note shall be added to the plat stating the following: "Lot A driveway placement shall be constructed as shown on sheet 6 of 9."
- c. Page 7 of 9: there is a note that states the following "existing impervious surfaces to be removed under separate demo permit, typical." The applicant has decided to apply for the demo permit after preliminary plat review. A condition of approval will be that the applicant shall update the lot coverage, hardscape, and impervious surface calculations for the final plat application.

Geotechnical Engineering:

7. Refer to Attachment B, Geotechnical Peer Review Letter. Please have your Geotechnical Engineer provide a statement of risk pursuant to MICC 19.07.160(B)(3).

Civil Engineering:

Contact: Ruji Ding, Senior Development Engineer, at ruji.ding@mercerisland.gov or 206-275-7703.

8. Refer to eplan review comments here:

https://MIePlan.mercergov.org/adobe/eplan/~CurrentSharedReviews/SUB21-002-SUB2-PLANS-120921 review.pdf.

To access the commented file, you will need to supply "eguest@mercergov.org" as the username and "@mercer123" for the password.

Trees:

Contact: John Kenney, City Arborist at john.kenney@mercerisland.gov or 206-275-7713.

9. No additional comments.

With your resubmittal, please provide a cover letter responding to each of the items above. Please reference page/sheet numbers noting where the requested information can be found. An incomplete resubmittal may delay your project.

The City's processing of the Short Plat application has been put on hold until these issues are resolved. Pursuant to MICC 19.15.110, all requested information must be submitted within 90 days or a request for extension requested. The deadline for a complete response or request for extension is June 15, 2022. If a complete response is not received or an extension response has been received prior to that date, the application will expire and be canceled for inactivity. No additional notification regarding this deadline or expiration of the application will be provided.

Please do not hesitate to contact me at 206-275-7704 or via e-mail at <u>lauren.anderson@mercergov.org</u> if you have any questions.

Sincerely,

Lauren Anderson


Lawren Anderson

Planner


City of Mercer Island Community Planning and Development

Enclosed:

Attachment A: Building Pad Area Example
Attachment B: Geotechnical Peer Review Letter

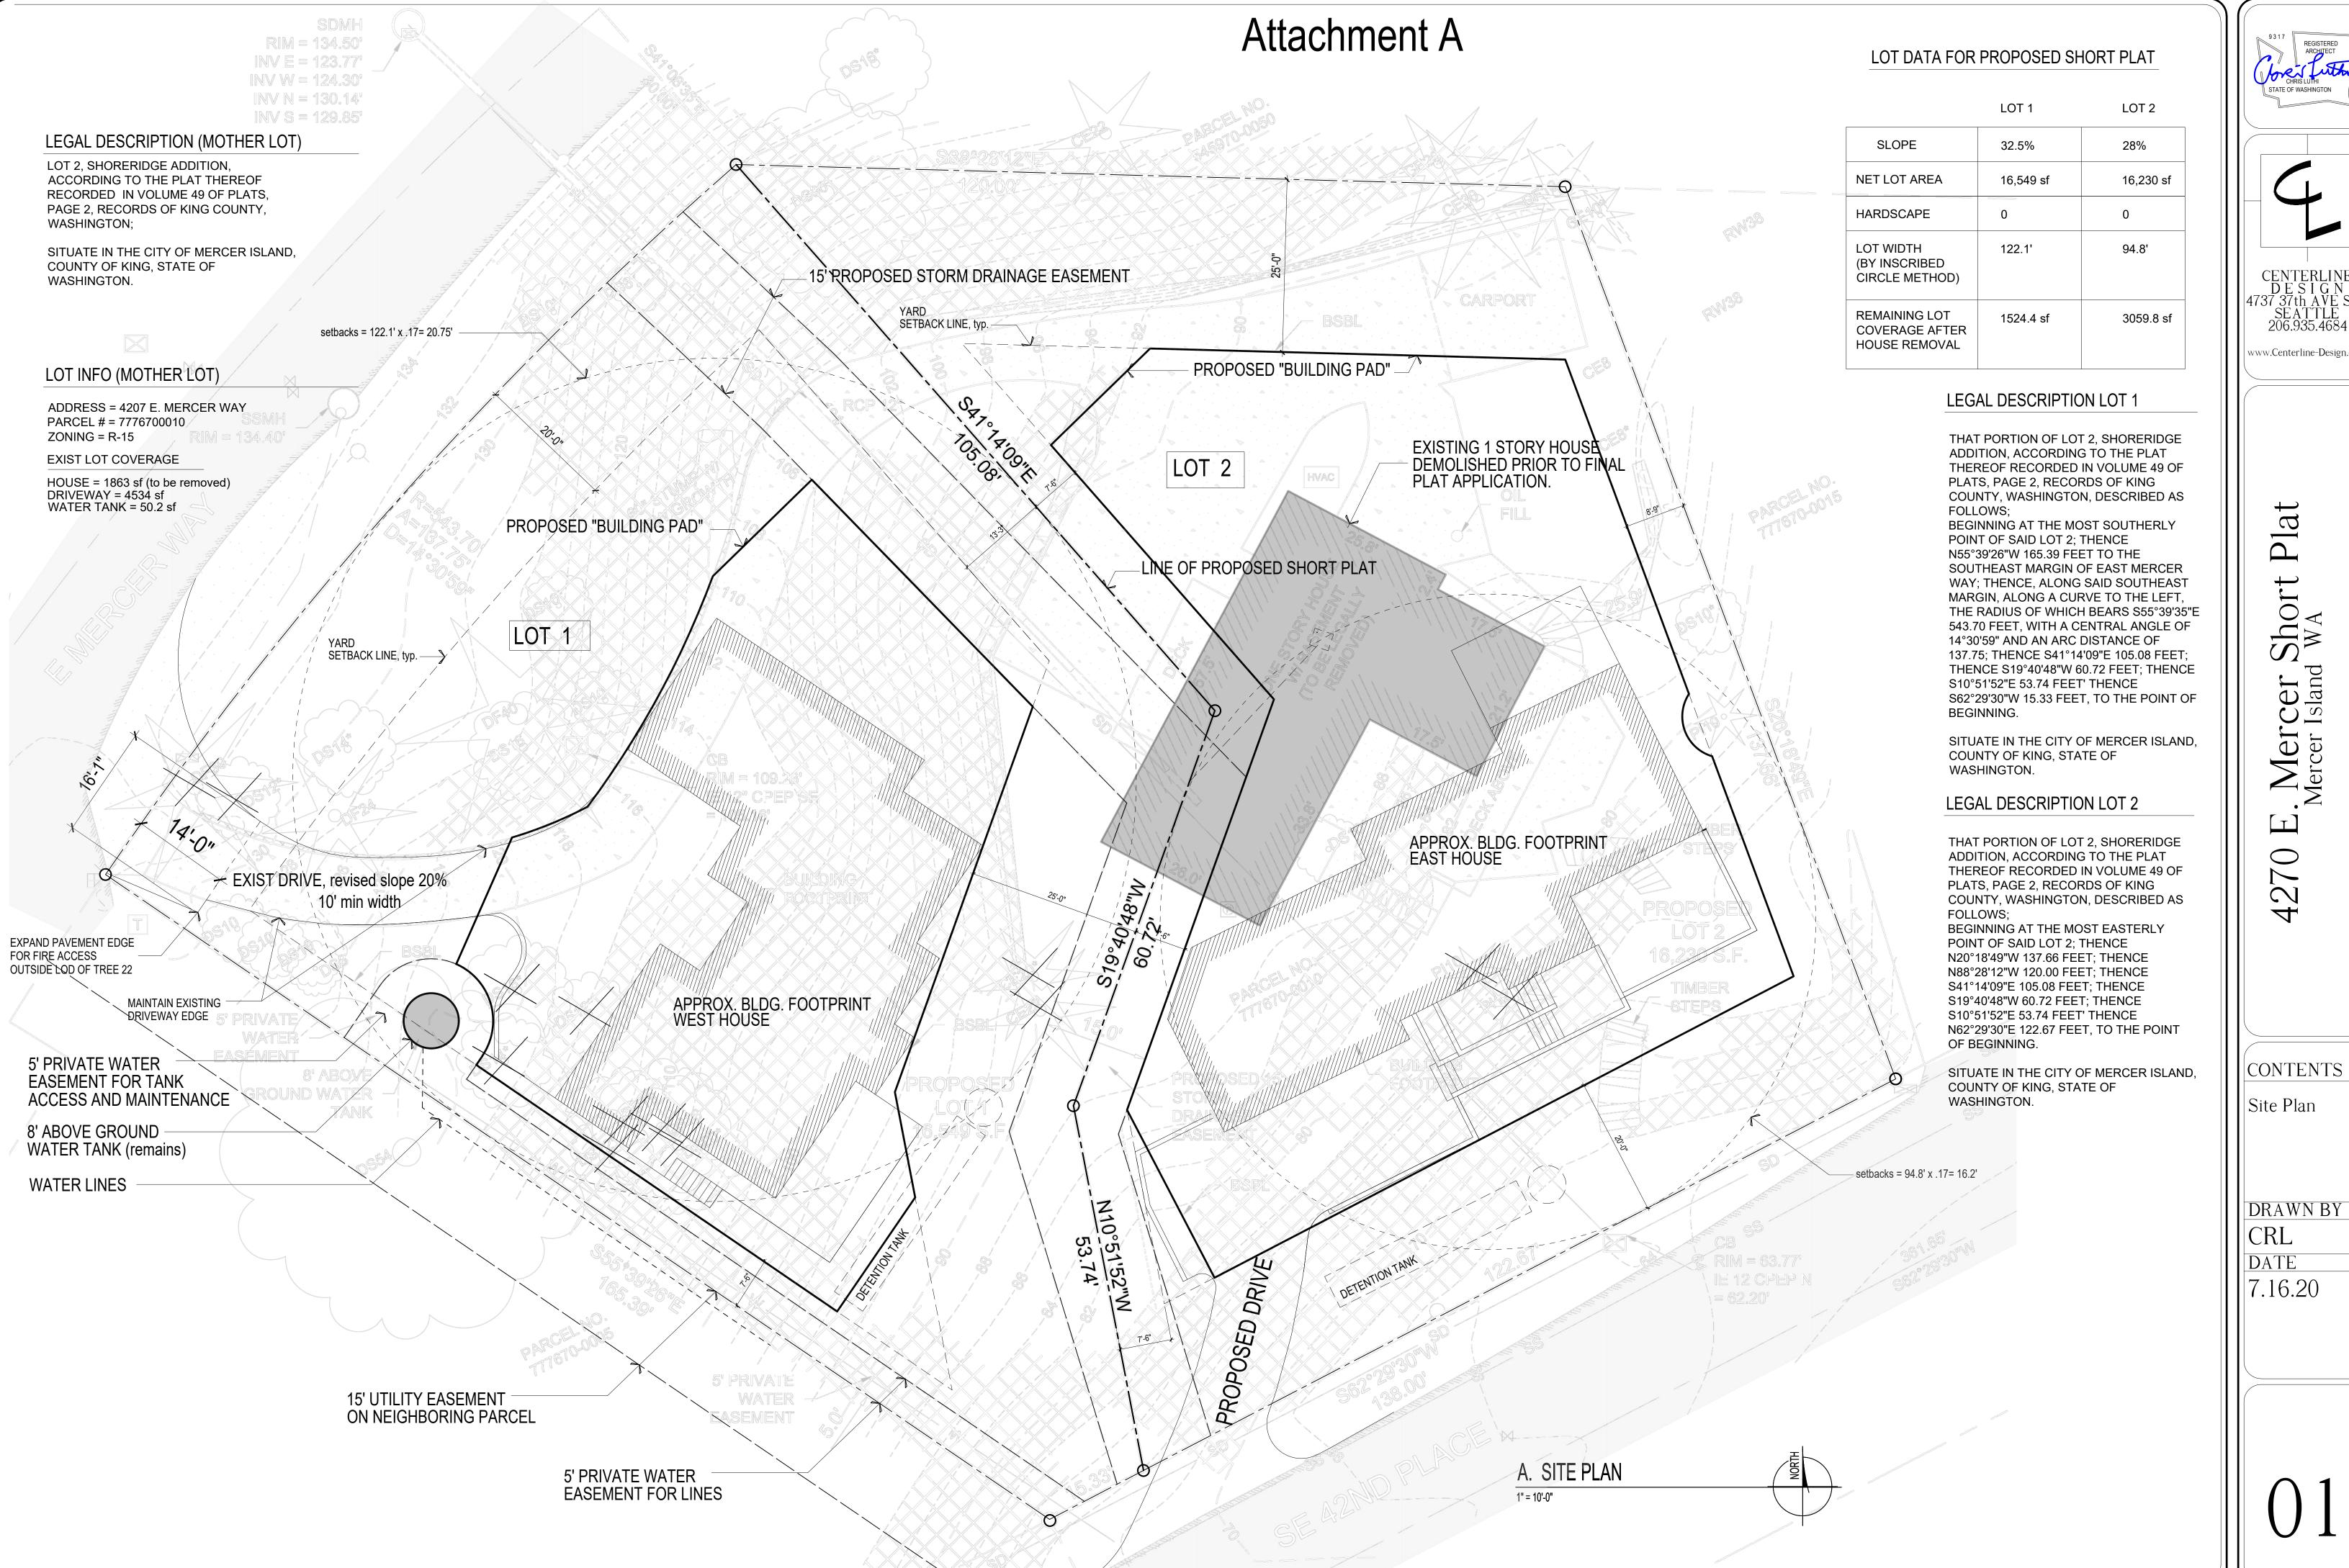

CHRIS LUTHI STATE OF WASHINGTON

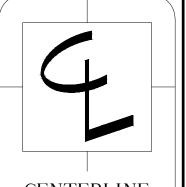

CENTERLINE DESIGN 4737 37th AVE SW SEATTLE 206.935.4684

Shoj WA

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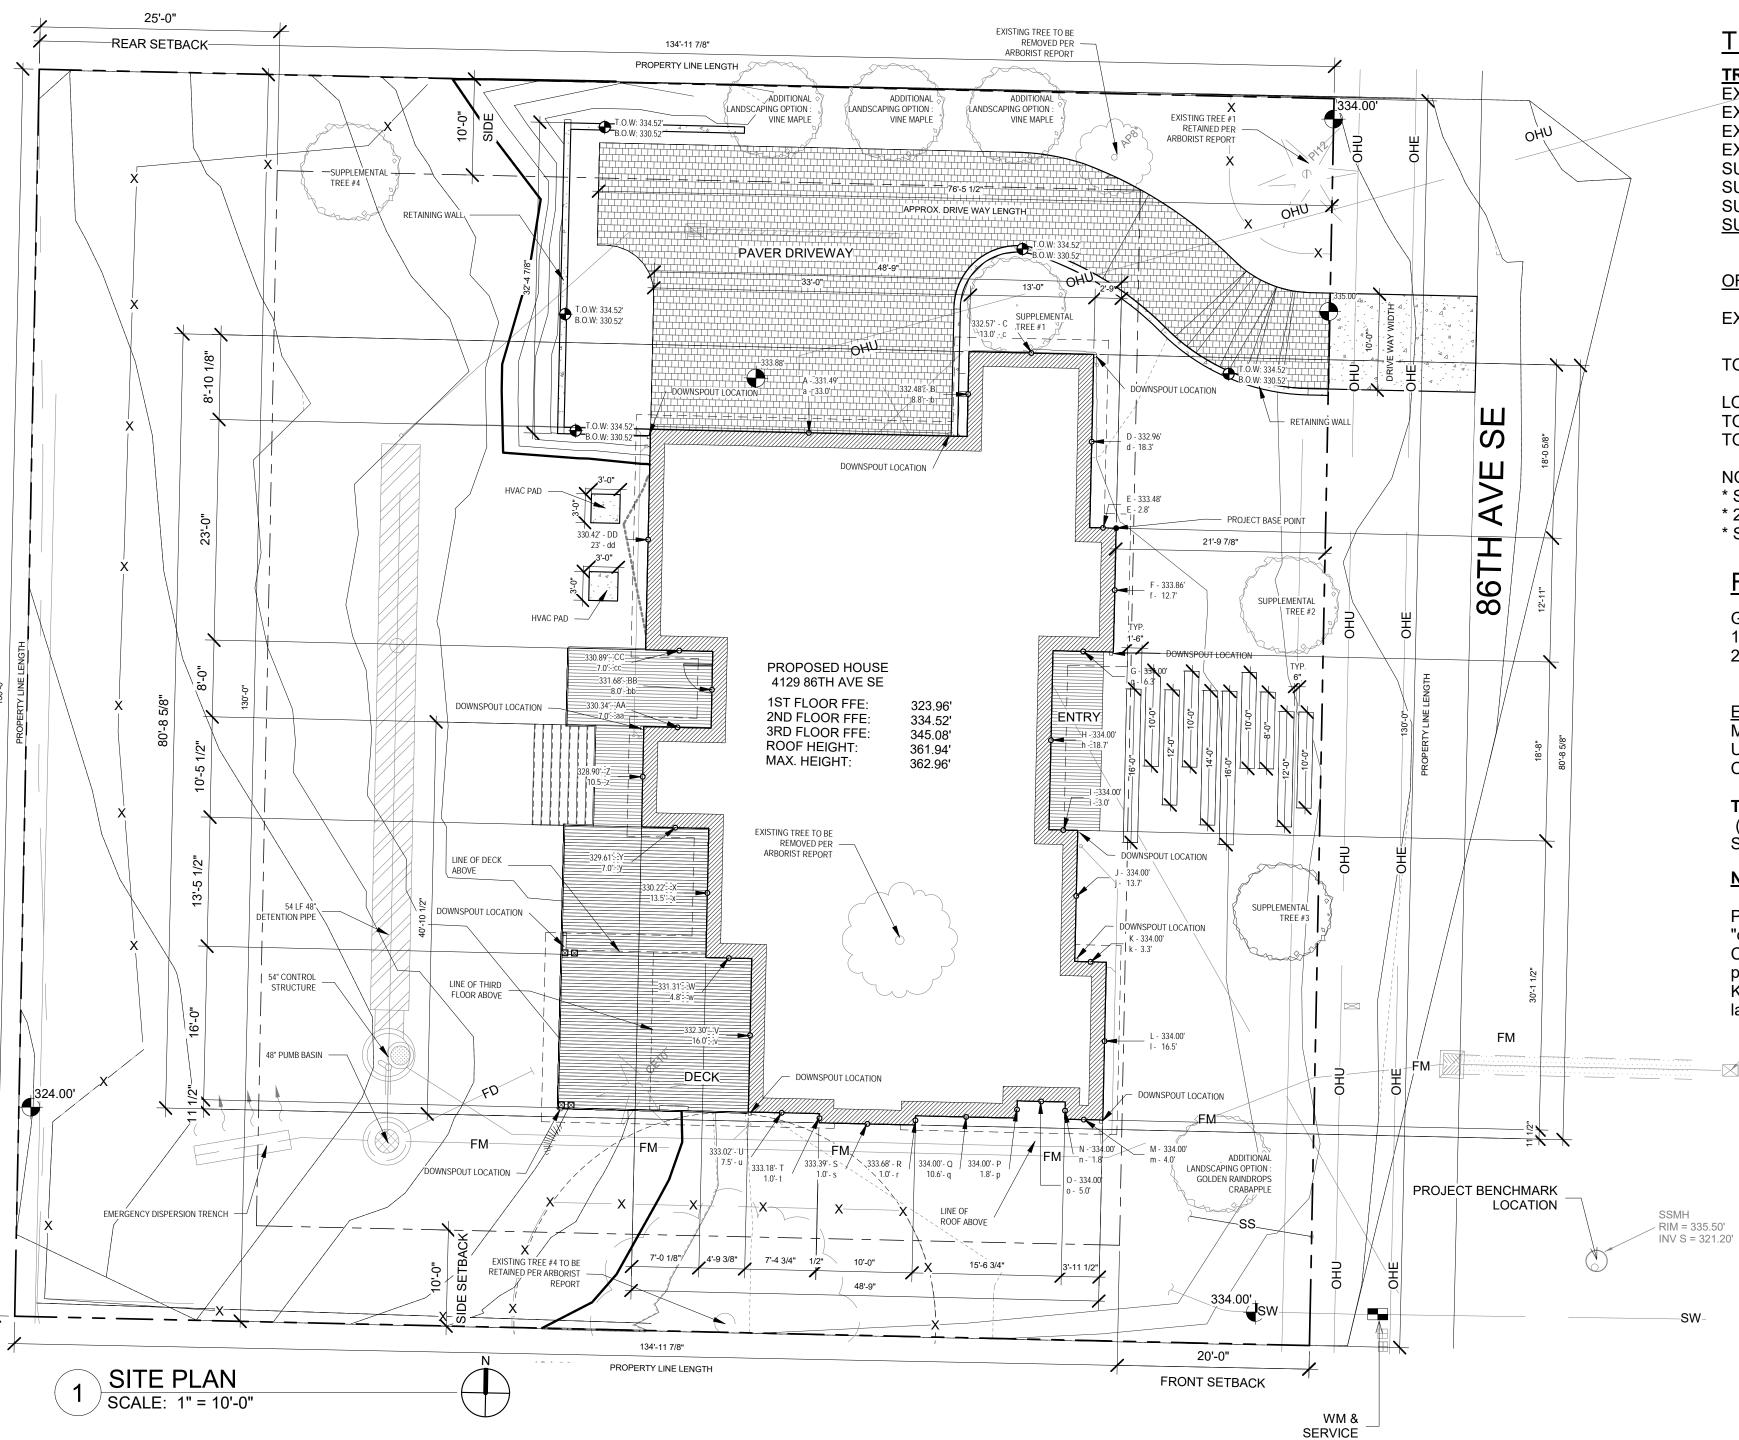
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www.Centerline-Design.com

Site Plan

DRAWN BY CRL

DATE 7.16.20



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AVERAGE	DUILUING I	CALCULATION

\wedge	TAGE DOILDING	<u> </u>		1 CALCULA
MIDF	POINT ELEVATION *	WAL	L LENGTH	= PRODUCT
Α	331.49	а	33.0	10939.2
В	332.48	b	8.8	2940.1
С	332.57	С	13.0	4323.4
D	332.96	d	18.3	6093.2
E F	333.48	е	2.8	917.1
	333.86	f	12.7	4230.0
G	334.00	g	6.3	2100.9
Н	334.00	h	18.7	6235.8
I	334.00	i	3.0	1002.0
J	334.00	j	13.7	4565.8
K	334.00	k	3.3	1098.9
L	334.00	I	16.5	5497.6
M	334.00	m	4.0	1322.6
Ν	334.00	n	1.8	597.7
0	334.00	0	5.0	1670.0
Р	334.00	р	1.8	597.9
Q	333.98	q	10.6	3523.5
R	333.68	r	1.0	320.3
S	333.39	S	10.0	3333.9
Τ	333.18	t	1.0	319.9
U	333.02	u	7.5	2481.0
V	332.30	V	16.0	5316.8
W	331.31	W	4.8	1583.7
X	330.22	Χ	13.5	4444.8
Υ	329.61	У	7.0	2310.6
Z	328.90	Z	10.5	3440.3
AA	330.34	aa	7.0	2315.7
BB	331.68	bb	8.0	2653.4
CC	330.89	CC	7.0	2319.5
DD	330.42	dd	23.0	7599.7
	TOTAL		289.1	96,095.20

AVERAGE BUILDING ELEVATION:		332.9
MAX HEIGHT ALLOWED	+	30'-0'
MAX ELEVATION	=	362.9
PROPOSED TOP OF BLDG	=	362.4
AMOUNT BELOW MAX	=	.52'

	SERVICE	
HARD SCAPE CALCULATION	N	
LOT SIZE		17,550 SF
ZONE R - 9.6 = 40%		7,020 SF
	AREA 100%	SUB-TOTAL
STRUCTURES OTHER THAN BLDG (STORMWATER DETENTION PIPE)	306	306
STAIRS / WALKWAYS / DECKS / HVAC PAD @ 100%	754	754
TOTAL HARD SCAPE AREA %	1,060	(6.03%)
TOTAL AREA OF HARDSCAPE		1,060 SF

LOT COVERAGE CALCULATION				
LOT SIZE			17,550 SF	
ZONE R - 9.6 = 40%			7,020 SF	
	AREA 100%	AREA EXEMPT	SUB-TOTAL	
MAIN STRUCTURE ROOF AREA	3,904		3,904	
DRIVEWAY	1438		1438	
TOTAL LOT COVERAGE AREA %	5,342		(30.43%)	
TOTAL PROPOSED EXEMPT AREA	0		5,342SF	
ALLOWED 9% EXEMPT AREA	528		0.00% OF 9% USED	

TREE DENSITY CALCULATION

	TREE DENSITY CALCULATION	REMOVED / NEW	DBH (IN.)	VIABLE TREE	DRIP LINE RADIUS (FT)	TREES REPLACEME	<u>:N</u>
	EXISTING TREE #1 - SPRUCE SPP.	TO BE RETAINED	11"	2	8'		
_	EXISTING TREE #2 - ORNAMENTAL CHERRY	TO BE REMOVED	13"	3	7'	2	
	EXISTING TREE #3 - HINOKI CYPRESS	TO BE REMOVED	10"	1	10'	2	
	EXISTING TREE #4 - BIG LEAF MAPLE	TO BE RETAINED	30"	1	22'		
	SUPPLEMENTAL TREE #1 - LARCH 'DIANA'	TO BE ADDED				1	
	SUPPLEMENTAL TREE #2 - MOUNTAIN HEMLOCK	TO BE ADDED				1	
	SUPPLEMENTAL TREE #3 - MOUNTAIN HEMLOCK	TO BE ADDED				1	
	SUPPLEMENTAL TREE #4 - COAST REDWOOD	TO BE ADDED				1	

OFFSITE TREES (TREE PROTECTION MESURES REQUIRED DURING CONSTRUCTION)

OFFSITE EXISTING TREE #4 - BIG LEAF MAPLE TO BE PROTECTED 30'

692 SF 2,223 SF

2352 SF

540 SF

157 SF

47 SF

6,011 SF

5000 SF

TOTAL TREES ON SITE

LOT SIZE

TOTAL CREDITS REQUIRED MATCHES EXISTING TREE CREDIT OR EXCEEDS IT TOTAL CREDITS PROVIDED

GARAGE

NOTE:

1ST FLOOR PLAN

2ND FLOOR PLAN

FIRE CALCULATION

EXTERIOR COVERED AREA

COVERED DRIVEWAY

SPRINKLER THRESHOLD

* SUPPLEMENTAL TREES TO MEET REQUIRED MINIMUM SIZE WORTH ONE TREE CREDIT AS OUTLINED IN KZC 95.33(4).

* 2" CALIPER FOR DECIDUOUS & 6-7 ft. TALL CONIFERS.

MAIN FLOOR COVERED DECK (FRONT AND REAR DECK)
UPPER FLOOR COVERED DECK

(TOTAL EXCEEDS THRESHOLD - SPRINKLERS REQ.)

* SPECIES TO BE SELECTED FROM CITY OF KIRKLAND PREFERRED PLANT LIST

GROSS FLOOR AREA CALCULATION

LOT AREA	17,550	SF
MAX GFA - R-9.6 = 40%	7,020	SF
GARAGE	725	SF
1ST FLOOR	2,327	SF
1ST FLOOR AREAS (+16' @ 200%)	330	SF
2ND FLOOR	2,288	SF
TOTAL	5,670 SF	
%	32.30 %	

CALL 48 HOURS BEFORE YOU DIG 811 OR <u>1-800-424-5555</u>

PER MICC 19.02.020(F)(3)(d) noxious weed removal:

"d. Development proposals for a new single-family home shall remove Japanese knotweed (Polygonum cuspidatum) and Regulated Class A, Regulated Class B, and Regulated Class C weeds identified on the King County Noxious Weed list, as amended, from required landscaping areas established pursuant to subsection (F)(3)(a) of this section. New landscaping associated with new single-family home shall not incorporate any weeds identified on the King County Noxious Weed list, as amended. Provided, that removal shall not be required if the removal will result in increased slope instability or risk of landslide or erosion."

LOT SLOPE

HIGHEST ELEVATION POINT OF LOT :	334	FEET
LOWEST ELEVATION POINT OF LOT:	324	FEET
ELEVATION DIFFERENCE:	10	FEET
HORIZONTAL DISTANCE BETWEEN HIGH AND LOW POINTS:	129.5	FEET

PROPOSED BUILDING PAD

20'-0" FRONT YARD SETBACK

PRICE PER SF: 120 DOLLARS PER SF TOTAL PROJECT VALUATION (ESTIMATION): \$ 672,480

LOT SLOPE: 8.3%

25'-0"

REAR SETBACK

3 SCALE: 1" = 20'-0"

29'-0 5/16"

PROJECT VALUATION

TOTAL SF : 5,604 SF

JOB ADDRESS: 4129 86TH AVE SE

DRAWING NAME:

SHEPLAN

Drawn By: J1	
Checked By: ST	
Owner Approval:	

PHASE:

CONSTRUCTION DOCUMENTS

This drawing is the exclusive property of MEDICI ARCHITECTS, and can be reproduced only with the permission of the Architect. Variations and modifications to work shown on this drawing shall not be carried out without

APPROVED FOR CONSTRUCTION:

TREE DRIPLINE BUILDING PAD DIAGRAM

20'-11"

PROPOSED HOUSE FOOT PRINT

∠4129 86TH AVE SE
√

EXISTING TREE #4 TO BE

REPORT: DRIP LINE - 22'-0"



- EXISTING PROPERTY LINE

SETBACK LINE (TYP)

ROOF EAVE OVERHANG



Issue Date **INTAKE DATE:**

RE	EVISIONS:	DATE:
1	REVISIONS PER CITY REQ.	02/23/201

PROJECT / CLIENT:

REGISTRATION:

4129 86TH AVE SE

ASPEN QUALITY HOMES

MERCER ISLAND, WA 98040

C	DI	ΛNI

written permission from the Architect.

PROJECT No.: 2017102 DATE: 4/19/2018 1000000

PLOT SCALE: 1:1

Attachment B

March 17, 2022

Lauren Anderson Planner Community Planning and Development (CPD) City of Mercer Island

Re: 4001 West Mercer Way Short Plat (SUB 21-002)

4001 West Mercer Way Mercer Island, Washington

This letter is provided at your request to address whether the proposed subdivision complies with the following Mercer Island City Codes (MICC).

- MICC 19.07.160 Geologically hazardous areas.
- MICC 19.09.090 Building pad. (Specifically, 19.09.090(A)(1)(b) and (c) as well as 19.09.090(A)(2)(c).

MICC 19.07.160 Geologically hazardous areas

A review of the geotechnical report provided for the proposed subdivision (Cobalt Geosciences, LLC, December 8, 2020) and their letter dated December 6, 2021 responding to SUB 1 comments is in general agreement with our assessment of the proposed subdivision.

However, the geotechnical engineer of record, Cobalt Geosciences, LLC., has not provided a risk statement that conforms to MICC 19.07.160.(B)(3).

MICC 19.09.090 Building pad. Specifically, 19.09.090(A)(1)(b) and (c) as well as 19.09.090(A)(2)(c)

- 19.09.090(A)(1)(b). Disturbance of the existing, natural topography as a result of anticipated development within the building pad shall be minimized;
- 19.09.090(A)(1)(c). Impacts to critical areas and critical area buffers shall be minimized, consistent with the provisions of Chapter 19.07 MICC; and
- 19.09.090(A)(2)(c). Building pads shall not be located within:
 - (c) Critical areas, buffers or critical area setbacks; provided building pads may be located within geohazard hazard areas and associated buffers and setbacks when all of the following are met:
 - i. A qualified professional determines that the criteria of MICC 19.07.160(B)(2) and (3), Site Development, are satisfied;
 - ii. Building pads are sited to minimize impacts to the extent feasible; and
 - iii. Building pads are not located in steep slopes or within 10 feet from the top of a steep slope, unless such slopes, as determined by a qualified professional, consist of soil types determined not to be landslide prone.

In my opinion, the proposed subdivision meets the requirements of MICC 19.09.090(A)(1)(b) and (c) as well as 19.09.090(A)(2)(c), except for the lack of statement of risk as discussed previously.

Should further information be required, feel free to contact me.

Sincerely.

City of Mercer Island - CPD

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Michele Lorilla, P.E. Geotechnical Peer Reviewer